
EAST TUNNEL CONDENSATE LINE REPLACEMENT PROJECT


PROJECT NUMBER CP00422861
COLUMBIA, SC
CONSTRUCTION DOCUMENTS

D	RAWING INDEX	
GENERAL T1 TITLE SHE MECHANICAL M1 SITE PLAN M2 DETAILS, I AND LEGE	I NOTES, MANHOLE DIAGRAM	CAMPUS PLANNING AND CONSTRUCTION COLUMBIA, SC 29208
		BUILDING: CP00422861 20MAR15 DRAWN BY: WCL WCCKED BY: SEAL: CP00422861 20MAR15 DESCRIPTION DATE ORIG. BY DRAWN BY REV. DESCRIPTION DATE ORIG. BY DRAWN BY
		PROJECT TITLE: EAST TUNNEL CONDENSATE LINE REPLACEMENT PROJECT NO. CP00422861 PROJECT NO. CP00422861 University of South Carolina
	Swygert & Associates CONSULTING ENGINEERS DBA Swygert & Assoc., Ltd. Post Office Box 11686 Columbia, S.C. 29211 Telephone: (803) 791–9 Facsimile: (803) 791–0 mail@swygert-associates	OF 9300 830

- 1) NEW EXPANSION JOINT XJ-1 IN NEW 4" PUMPED CONDENSATE LINE.
- 2) NEW EXPANSION JOINT XJ-1 IN EXISTING 4" PUMPED CONDENSATE LINE.
- 3) NEW PIPE GUIDE IN NEW PUMPED CONDENSATE LINE.
- 4) NEW PIPE GUIDE IN EXISTING PUMPED CONDENSATE LINE.
- 5 PROVIDE ANCHOR TO EXISTING STRUCTURE PER DETAIL ON SHEET M2.
- 6 REPLACE EXISTING AND PROVIDE NEW GATE VALVE IN VAULT PER DETAIL ON SHEET M2. PROVIDE NEW DRIP TRAP ASSEMBLY PER DETAIL ON SHEET M2.
- 7 REPLACE EXISTING PUMPED CONDENSATE PIPE WITH NEW 4" PUMPED CONDENSATE PIPE AS SHOWN.
- 8 REPLACE EXISTING CONDENSATE PIPE 10' OUTSIDE THE VAULT AND BACK THROUGH A NEW CORE DRILLED OPENING TO THE MAIN PUMPED

CONDENSATE PIPE IN THE TUNNEL. SEAL OPENING WITH LINK SEAL.

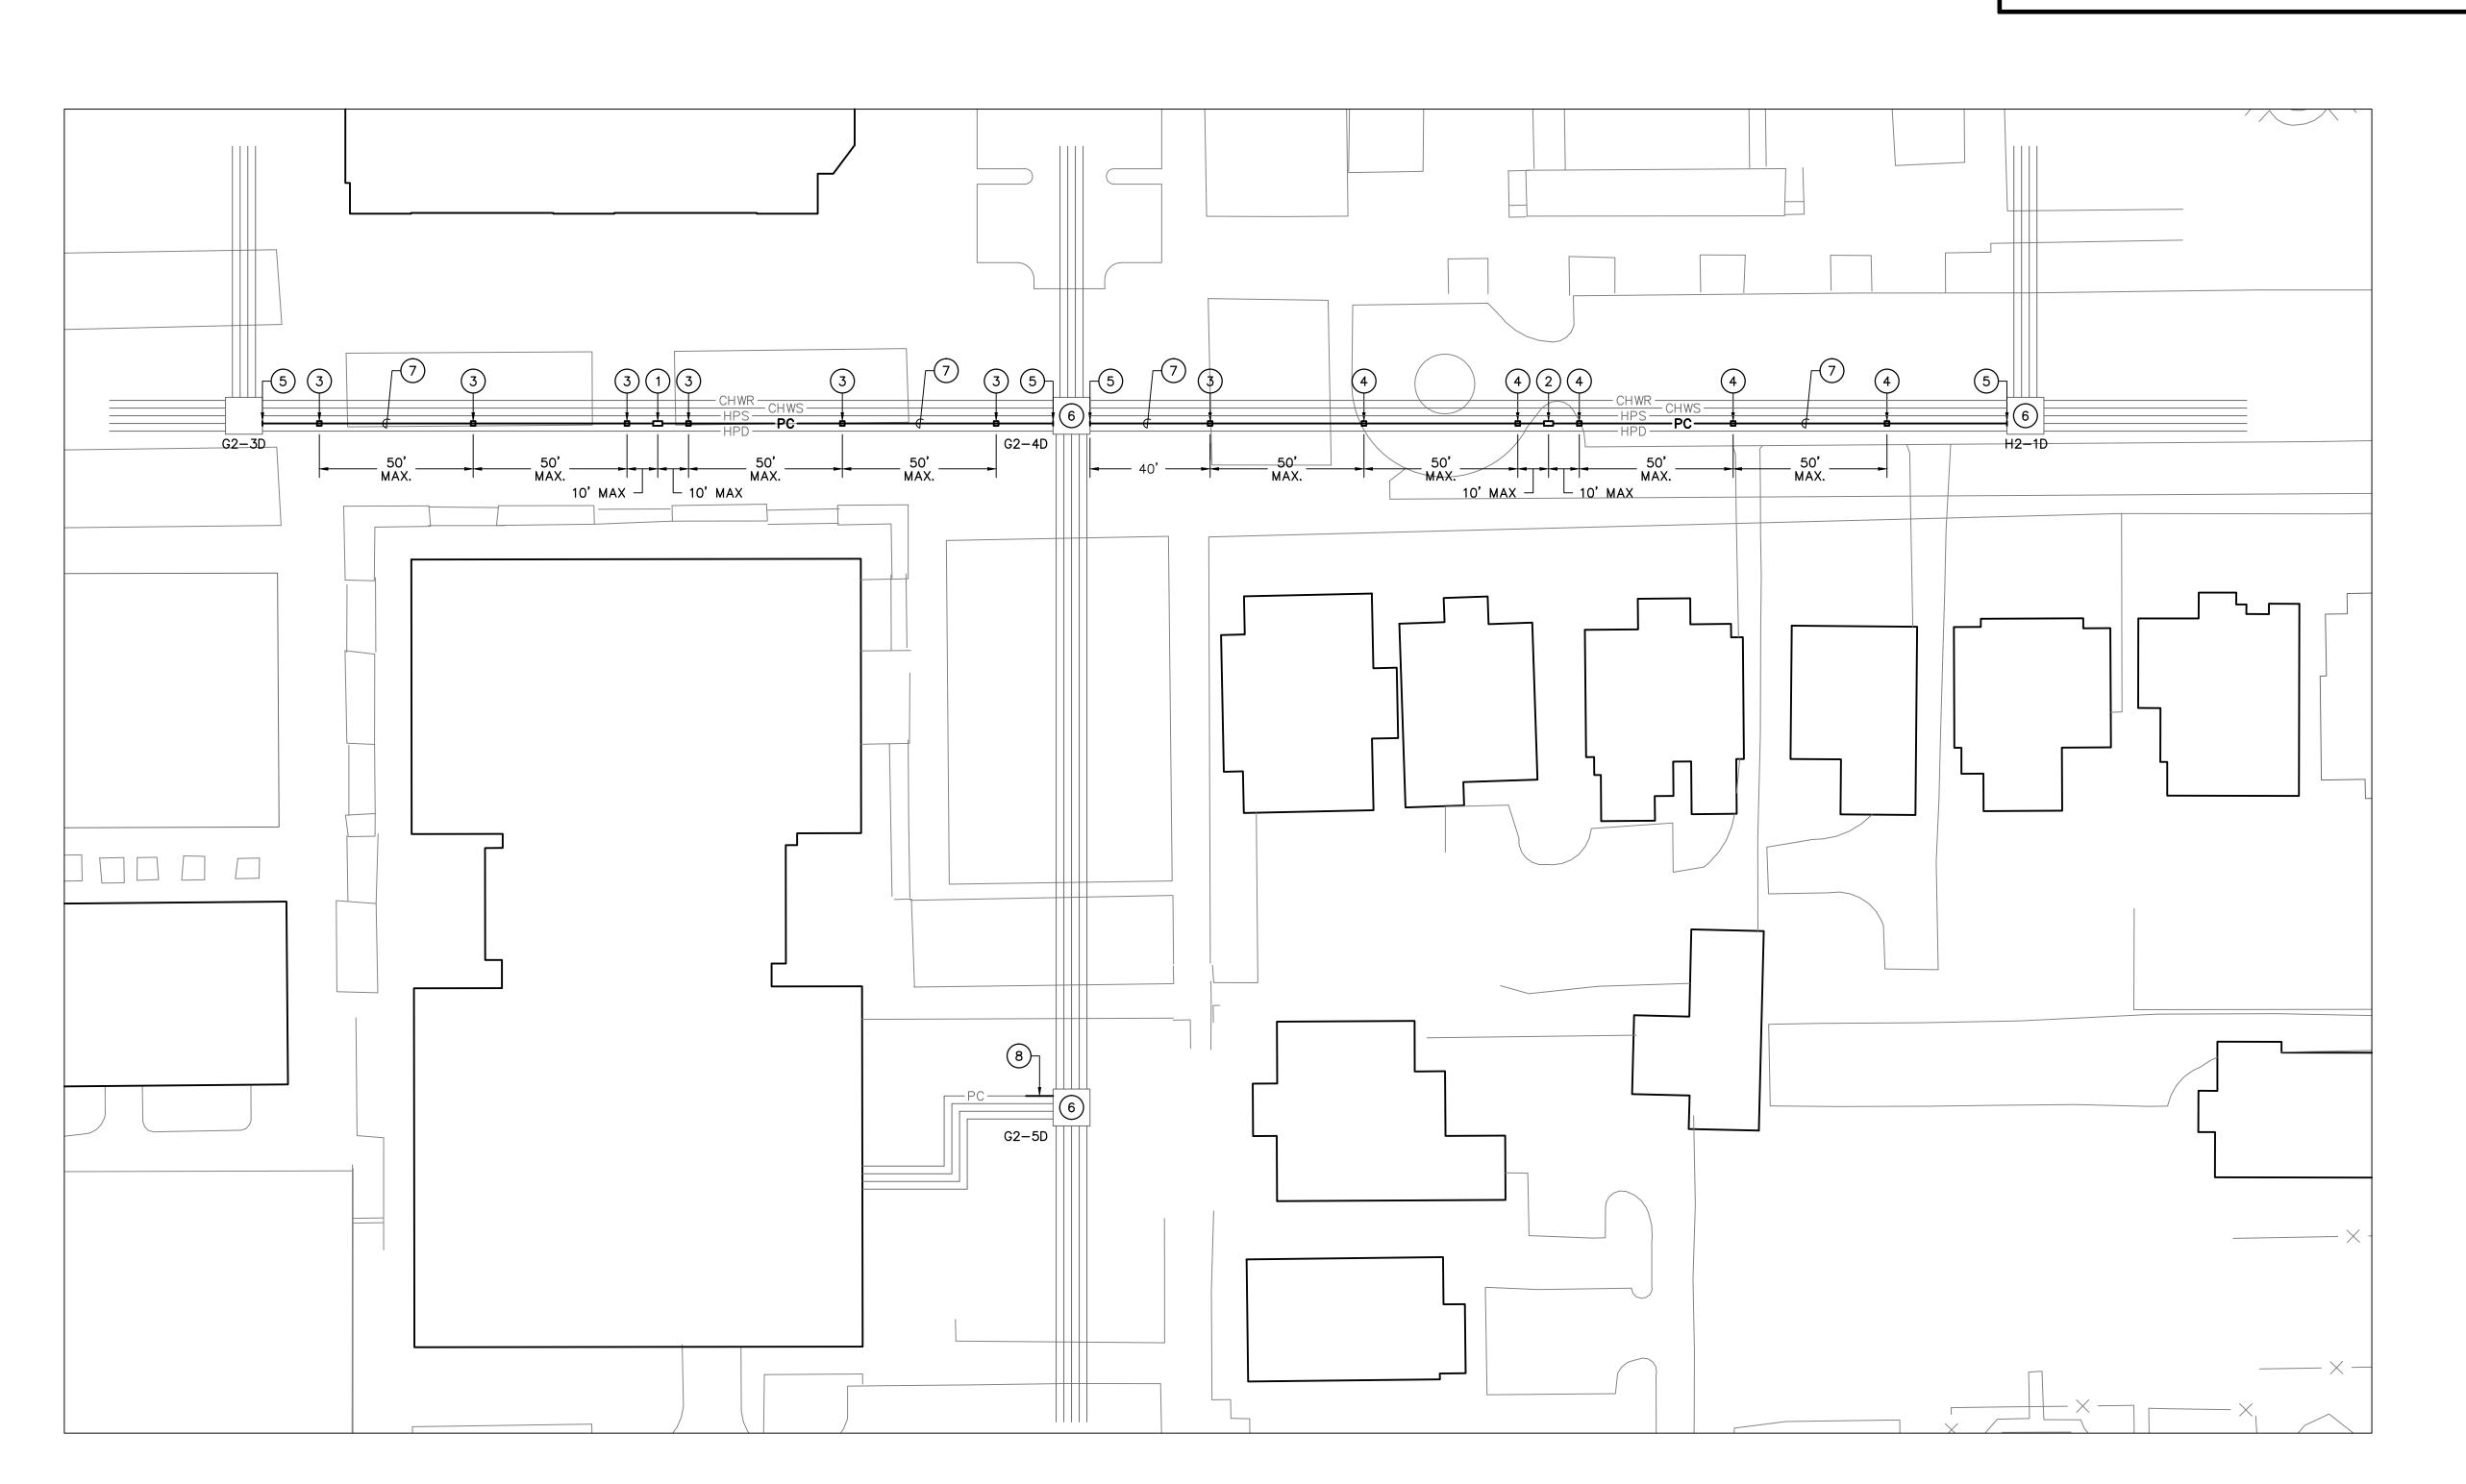

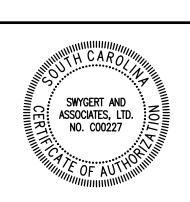


Swygert & Associates CONSULTING ENGINEERS

M-1SHEET IN SET:

OF

SITE PLAN — RENOVATION

SCALE: 1" = 30'

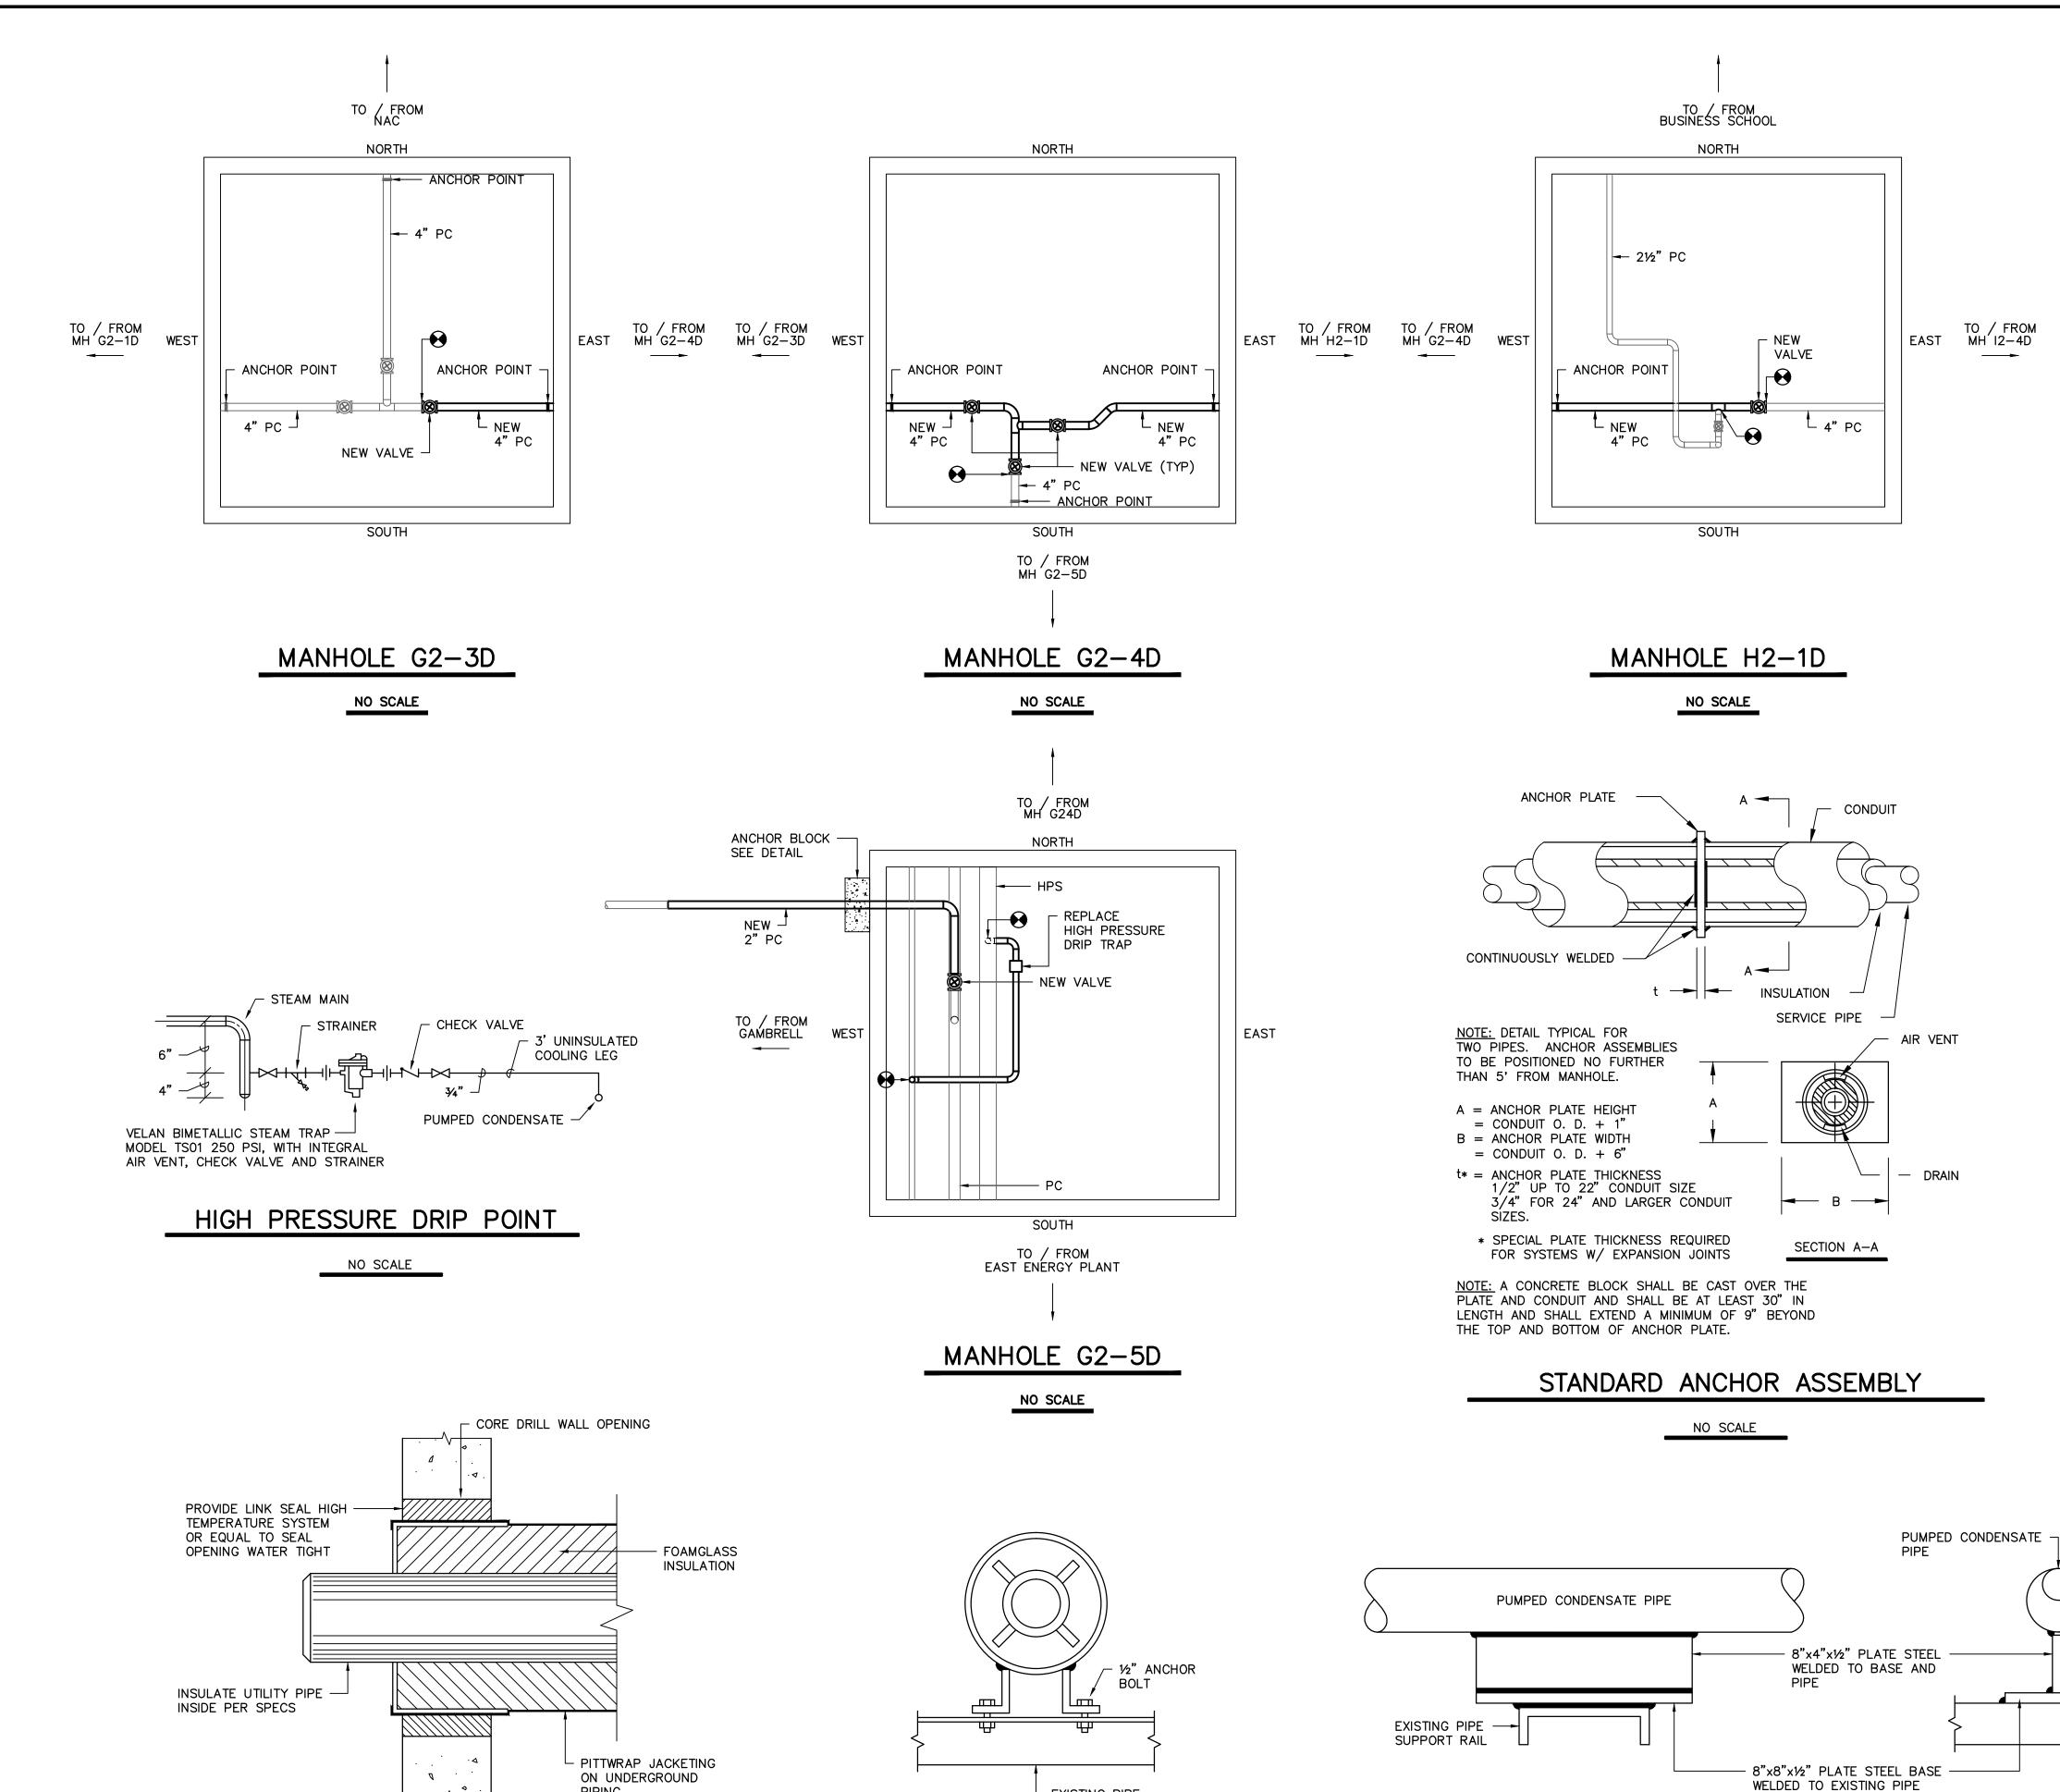

- EXISTING PIPE

SUPPORT RAIL

PIPE GUIDE DETAIL

NO SCALE


UTILITY PIPE ENTRY DETAIL

NO SCALE

GENERAL NOTES

- 1. DO NOT SCALE DRAWINGS. VERIFY ALL REQUIRED INFORMATION IN THE FIELD BY VISITING SITE PRIOR TO SUBMITTING BID.
- 2. EXACT ROUTING OF PIPING SHALL BE SET IN FIELD TO MINIMIZE CONFLICTS WITH ALL ABOVE AND UNDERGROUND STRUCTURES, TREES, FENCES, WALKS, WALLS, AND UTILITIES.
- 3. ALL PIPING IS SHOWN DIAGRAMMATIC. HOWEVER, CONTRACTOR SHALL PROVIDE ALL REQUIRED FITTINGS, PIPING, AND INSULATION FOR ALL OFFSETS AND/OR CHANGES IN ELEVATIONS. WHERE NECESSARY DUE TO INTERFERENCE, CONTRACTOR SHALL MODIFY EXISTING PIPING, EQUIPMENT, ETC.
- 4. ALL VALVES AND SPECIALTIES SHALL BE LINE SIZE UNLESS INDICATED OTHERWISE ON DRAWINGS.
- 5. ALL STEAM AND PUMPED CONDENSATE SHALL PITCH DOWN A MINIMUM OF ONE INCH PER FIFTY FEET.
- 6. ALL OPENINGS THROUGH EXISTING STRUCTURES SHALL BE CORE DRILLED.
- 7. COLD SPRING ALL STEAM LINES FIFTY (50) PERCENT.
- 8. WHERE PIPING ENTERS MANHOLE CONSTRUCT ENTRY AS REQUIRED. ALL PIPES TO BE SLEEVED AND LINK SEALED TO MAKE WATERTIGHT.
- 9. ALL PIPING AND FITTINGS IN MANHOLES TO BE INSULATED, SEE SPECIFICATIONS.
- 10. CONTRACTOR SHALL COORDINATE AND OBTAIN APPROVAL FROM OWNER FOR INTERRUPTIONS AND CONNECTIONS TO EXISTING UTILITY SYSTEMS.
- 11. CONTRACTOR SHALL COORDINATE TREE AND LANDSCAPING REPLACEMENT WITH USC. IN GENERAL USC WILL REPLACE SMALL TREES THAT ARE NOTED TO BE REPLACED. CONTRACTOR IS RESPONSIBLE FOR SOD REPLACEMENT.
- 12. ALL PIPING SHALL BE VENTED OF AIR AND FILLED WITH THEIR NORMAL FLUIDS OR GAS.
- 13. CONTRACTOR SHALL CONTACT PALMETTO UTILITY PROTECTION SERVICES TO LOCATE UTILITIES PRIOR TO DIGGING. INFORMATION OBTAINED FROM PALMETTO UTILITY PROTECTION SERVICES AND DURING DIGGING SHALL BE INDICATED ON THE AS-BUILT DRAWINGS.
- 14. CONSTRUCT TEMPORARY FENCING AROUND PROJECT AREA TO PROTECT THE SITE AND PEDESTRIANS.

LEGEND			
SYMBOL	DESCRIPTION		
~ —s—→	NEW HIGH PRESSURE STEAM LINE		
 PC 	NEW PUMPED CONDENSATE LINE		
۶	EXISTING PIPE TO BE REMOVED OR ABANDONED		
<pc< th=""><th>EXISTING PUMPED CONDENSATE LINE</th></pc<>	EXISTING PUMPED CONDENSATE LINE		
<i>⊱</i> —−8——→	EXISTING HIGH PRESSURE STEAM LINE		
← GC − − →	EXISTING GRAVITY CONDENSATE LINE		
<	EXISTING CHILLED WATER RETURN LINE		
<	EXISTING CHILLED WATER SUPPLY LINE		
⊱ ——E——→	EXISTING HIGH VOLTAGE ELECTRICAL LINE		
~—C—→	EXISTING COMMUNICATIONS LINE		
← EC ← C	EXISTING ELECTRICAL AND COMMUNICATIONS PRIMARY DUCT		
	EXISTING SANITARY SEWER LINE		
← HG — →	EXISTING HIGH PRESSURE GAS LINE		
∠ LG — ~	EXISTING LOW PRESSURE GAS LINE		
<> SD>	EXISTING STORM DRAIN LINE		
├──	VELAN GATE VALVE, SEE SPECS		
•	CONNECTION POINT OF NEW TO EXISTING		

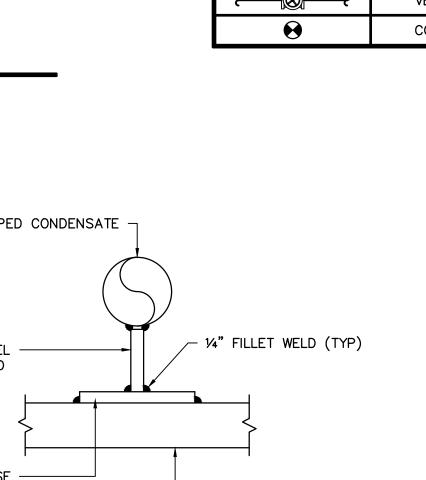


EXISTING PIPE SUPPORT RAIL



SUPPORT RAIL

NO SCALE

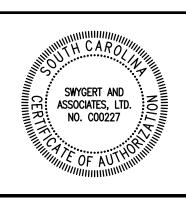

Swygert & Associates

CONSULTING ENGINEERS

DBA Swygert & Assoc., Ltd.
Post Office Box 11686
Columbia, S.C. 29211

Telephone: (803) 791-9300
Facsimile: (803) 791-0830
mail@swygert-associates.com

M-2

OF

SHEET IN SET:

OF

0042

СР

EAS REPI PRO

PLANNING ISTRUCTION A, SC 29208

CAMPUS FAND CONS